

Northeast Elevation [Elevation A]

Scale : 1:200

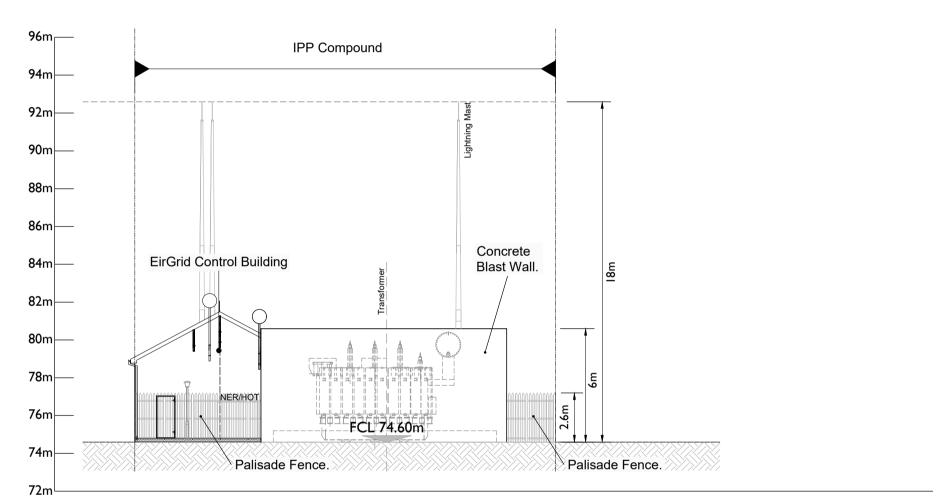


Southeast Elevation [Elevation B]

Scale : 1:200

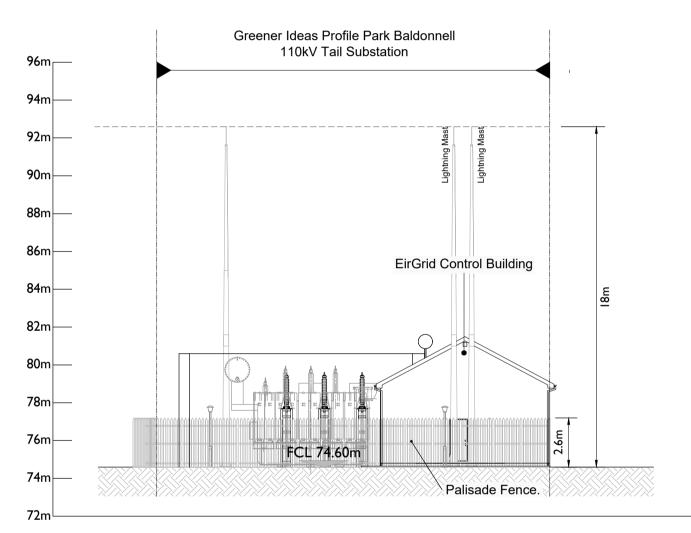

Northwest Elevation [Elevation D]

Scale : 1:200

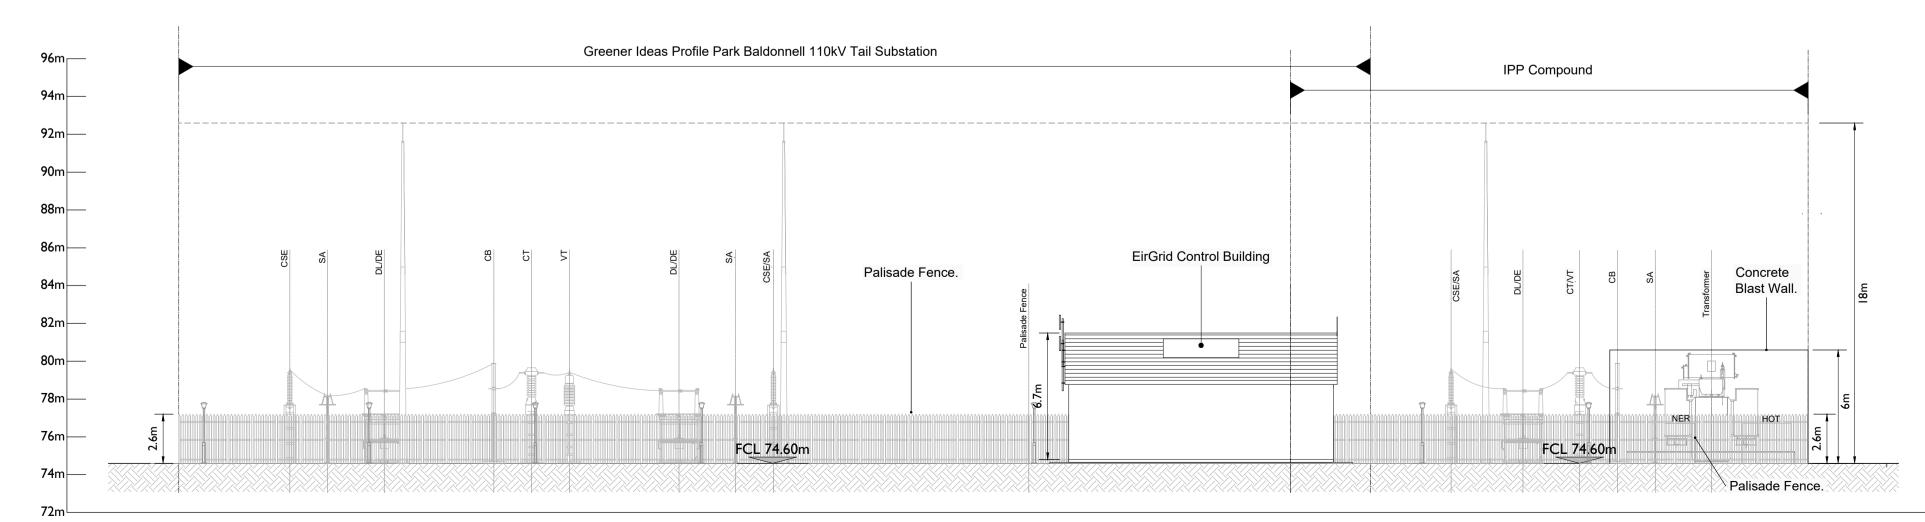

Southwest Elevation [Elevation C]

Scale : 1:200



Head Office
Beenreigh,
Abbeydorney,
Tralee, Co. Kerry
Ireland
Tel: 00353 66 7135710

Regional Office
Basepoint Business Centre
Stroudley Road, Basingstoke,
Hampshire,
RG24 8UP, UK
Tel: 00 44 1256406664

PROJECT

110kV Baldonnell Substation

CLIENT



CONSULTANTS

NOTES:

- Layout and Arrangements of Substation Building and Electrical Equipment is shown indicatively and for illustration purposes only.
- Dimensions shown are as per current Eirgrid Specifications at the time of submission. Dimensions may vary at time of
- construction to reflect any revisions to Eirgrid

 3. Final Specifications of Buildings and Electrical Equipment is to be as per Eirgrid and ESB Specifications.
- The Elevation of the Compound will be depicted by localized
- Topography such that Cut/Fill Earthworks associated with the construction of the Compound are balanced.

LEGEND: -

	Description
SA	Surge Arrester.
DL/DE	Line / Earth Disconnect.
VT	Voltage Transformer.
CT	Current Transformer.
CT/VT	Voltage/Current Transformer
CSE	Cable Sealing End
СВ	Circuit Breaker.
TRAFO	110kV Transformer
LM	Lightning Mast
NER	Neutral Earthing Resistor
НОТ	House Transformer

Proposed Compound Levels shown thus

ISSUE/REVISION

РЗ	19.05.23	Issued for Planning
P2	15.03.23	Issued for Planning
P1	24.02.23	Issued for Planning
I/R	DATE	DESCRIPTION
		-

PROJECT NUMBER

05-868

SHEET TITLE

Proposed Baldonnell 110kV Substation - Elevations

SHEET NUMBER

05868-DR-032